DEVELOPMENT APPLICATION

ALTERATIONS AND ADDITIONS TO THE KAC ALPENHOF LODGE

6 Wheatley Rd, Perisher Valley NSW 2624



| Sheet Number | Sheet Name | Current | Current Revision Description | | | |
|---------------|------------------------------------|----------|------------------------------|-----------------------|----------------------------|----------|
| | | Revision | | Current Revision Date | Current Revision Issued To | Scale |
| | | • | | | | |
| A-000 | Cover Sheet | С | DA | 21.03.2024 | CLIENT | NTS |
| 4 -010 | Existing Site & Roof Plan | С | DA | 21.03.2024 | CLIENT | 1:500@A1 |
| A-100 | Existing Ground Floor Plan | С | DA | 21.03.2024 | CLIENT | 1:100@A1 |
| A-101 | Existing First Floor Plan | С | DA | 21.03.2024 | CLIENT | 1:100@A1 |
| A-102 | Existing Second Floor Plan | С | DA | 21.03.2024 | CLIENT | 1:100@A1 |
| A-110 | Proposed Ground Floor Plan | С | DA | 21.03.2024 | CLIENT | 1:100@A1 |
| A-111 | Proposed First Floor Plan | С | DA | 21.03.2024 | CLIENT | 1:100@A1 |
| A -112 | Proposed Second Floor Plan | С | DA | 21.03.2024 | CLIENT | 1:100@A1 |
| A-200 | Existing Elevations | С | DA | 21.03.2024 | CLIENT | 1:100@A1 |
| A-210 | Proposed Elevations | С | DA | 21.03.2024 | CLIENT | 1:100@A1 |
| \-400 | Balcony Details | Α | DA | 16.01.2024 | CLIENT | 1:10@A1 |
| A-500 | SITE ENVIRONMENTAL MANAGEMENT PLAN | Α | DA | 21.03.2024 | CLIENT | 1:500@A1 |

| С | 21.03.2024 | DA |
|---|------------|----|
| В | 15.03.2024 | DA |
| Α | 16.01.2024 | DA |
| | | |

boko

level 1 88 foveaux stree surry hills nsw 2010 australi ph(02) 9212 6606 f(02) 9212 6670 www.bokor.com.au

KOSCIUSKO ALPINE CLUB

KAC ALPENHOF LODGE
PERISHER VALLEY

awiiig

Cover She

CONTRACTORS MUST WEIRY ALL DIMENSIONS ON SITE PROOR TO STARTING ANY WORK OR ANNOR ANY SHOP DEAMINGS. FIGURE DIMENSIONS ARE TO TAKEN IN PREFERENCE TO SCALE READMOS. THE DRAWING IS COPYRIGHT AN THE PROPERTY OF BOXICA PTY LITD.

drawn checked scale project date

YA JB @ 61 JAN 2024





DEMOLITION NOTES

ALL DEMOLITION TO BE CARRIED OUT IN ACCORDANCE WITH THE REQUIREMENTS OF AS 2601 'THE DEMOLITION OF STRUCTURES'

ALL BUILDING MATERIALS ARISING FROM DEMOLITION TO BE DISPOSED OF IN AN APPROVED MANNER IN ACCORDANCE WITH COUNCIL, GUIDELINES AND ANY APPLICABLE REQUIREMENTS.

DURING DEMOLITION, STORMWATER & SANITARY DRAINAGE, WATER, ELECTRICITY & TELECOMMUNICATIONS ARE TO BE DISCONNECTED IN ACCORDANCE WITH RESPONSIBLE AUTHORITIES.

GENERAL CLEAN UP STANDARDS TO BE UNDERTAKEN - REMOVAL OF DUST, VEHICLES WHEELS

ALL EXCAVATION AND DEMOLITION TO BE CARRIED OUT DURING THE RESTRICTED TIMES DECIDED BY COUNCIL

EXISTING FINISHES ARE TO BE CAREFULLY PROTECTED FOR THE DURATION OF THE WORKS

DEMOLITION LEGEND

EXISTING ITEM TO BE DEMOLISHED.

PROPOSED ALTERATION

C 21.03.2024 DA B 15.03.2024 DA A 16.01.2024 DA

bokor

architecture + interiors


level 1 88 foveaux street surry hills nsw 2010 australia ph(02) 9212 6606 f(02) 9212 6670 w w w .b o k o r .c o m .a u RIJAMSS0 900 RIJAMSS 04000 RIJAMS 604000 RIJAMS 604000 RIJAMS 604000 RIJAMS 604000 RIJAMS 604000 RIJAMS

KOSCIUSKO ALPINE CLUB

KAC ALPENHOF LODGE PERISHER VALLEY

Existing Site & Roof Plan

project no. 24087 A-010

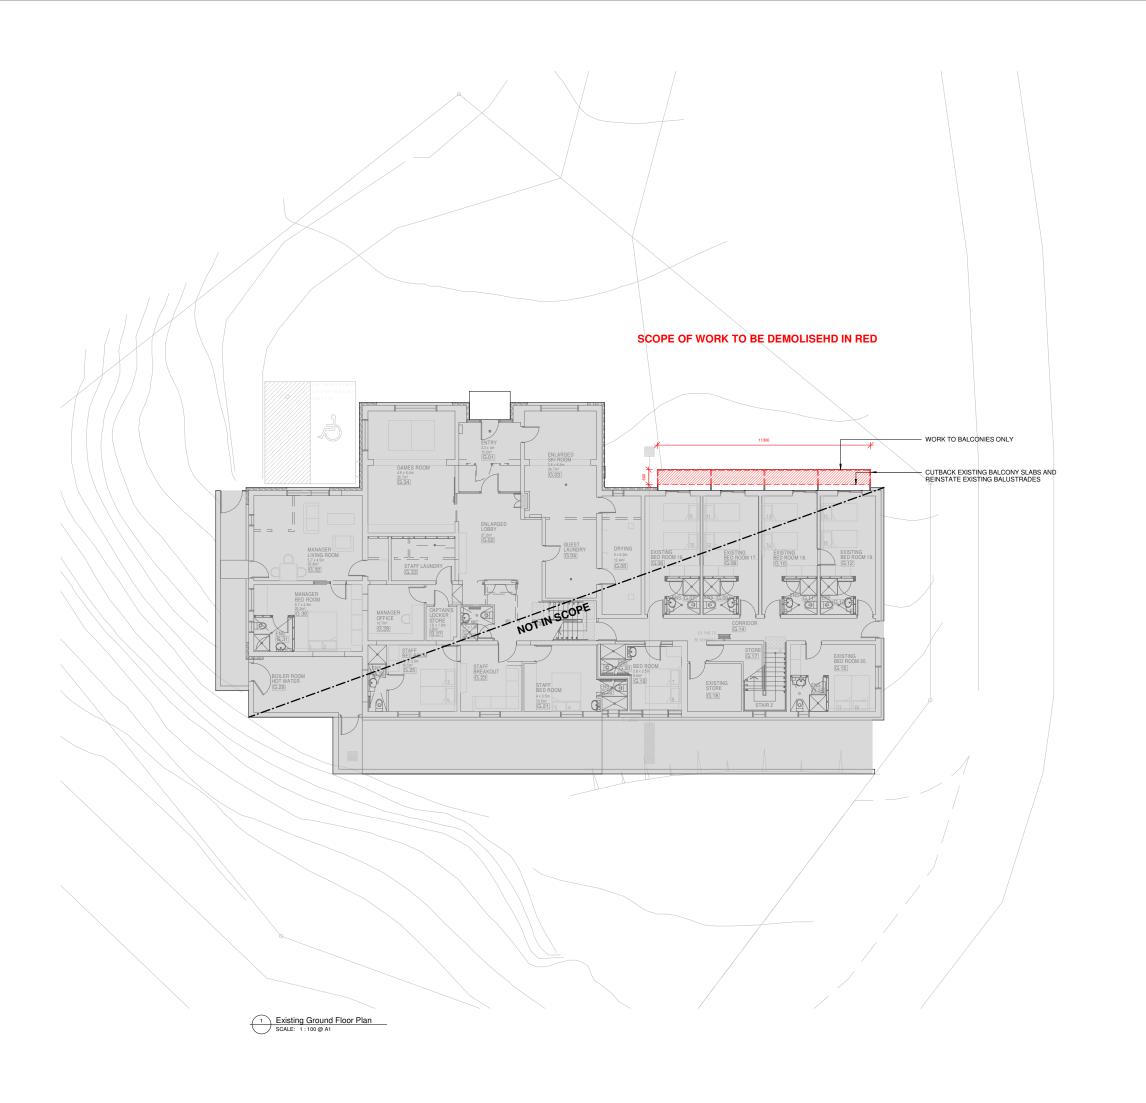



DEMOLITION NOTES

ALL DEMOLITION TO BE CARRIED OUT IN ACCORDANCE WITH THE REQUIREMENTS OF AS 2601 THE DEMOLITION OF STRUCTURES'

ALL BUILDING MATERIALS ARISING FROM DEMOLITION TO BE DISPOSED OF IN AN APPROVED MANNER IN ACCORDANCE WITH COUNCIL, GUIDELINES AND ANY APPLICABLE REQUIREMENTS.

DURING DEMOLITION, STORMWATER & SANITARY DRAINAGE, WATER, ELECTRICITY & TELECOMMUNICATIONS ARE TO BE DISCONNECTED IN ACCORDANCE WITH RESPONSIBLE AUTHORITIES.

RESPONSIBLE AUTHORITIES.

GENERAL CLEAN UP STANDARDS TO BE UNDERTAKEN - REMOVAL OF DUST, VEHICLES WHEELS

ALL EXCAVATION AND DEMOLITION TO BE CARRIED OUT DURING THE RESTRICTED TIMES DECIDED BY COUNCIL

EXISTING FINISHES ARE TO BE CAREFULLY PROTECTED FOR THE DURATION OF THE WORKS

DEMOLITION LEGEND

ZZZZ EXISTING ITEM TO BE DEMOLISHED.

PROPOSED ALTERATION

C 21.03.2024 DA RW B 15.03.2024 DA YA A 16.01.2024 DA YA

architecture+interiors

level 1 88 foveaux street surry hills nsw 2010 australia ph(02) 9212 6606 f(02) 9212 6670 w w w . b o k o r . c o m . a u

W W W . b o k o r . c o m . a u

RI A AS/NZS ISO 9001

RI A Certified

RI A Certified

RI A Certified

KOSCIUSKO ALPINE CLUB

KAC ALPENHOF LODGE
PERISHER VALLEY

Existing Ground Floor Plan

CONTRACTORS MUST VERIFY ALL DIMEN ANY WORK OR MAKING ANY SHOP DRAW TAKEN IN PREFERENCE TO SCALE READ THE PROPERTY OF BOKOR PTY LTD.


 drawn
 checked
 scale
 project date

 YA
 JB
 1:100 e A1
 JAN 2024

 project no.
 drawing no.
 issue

 24087
 A-100
 C

SCOPE OF WORK TO BE DEMOLISEHD IN RED

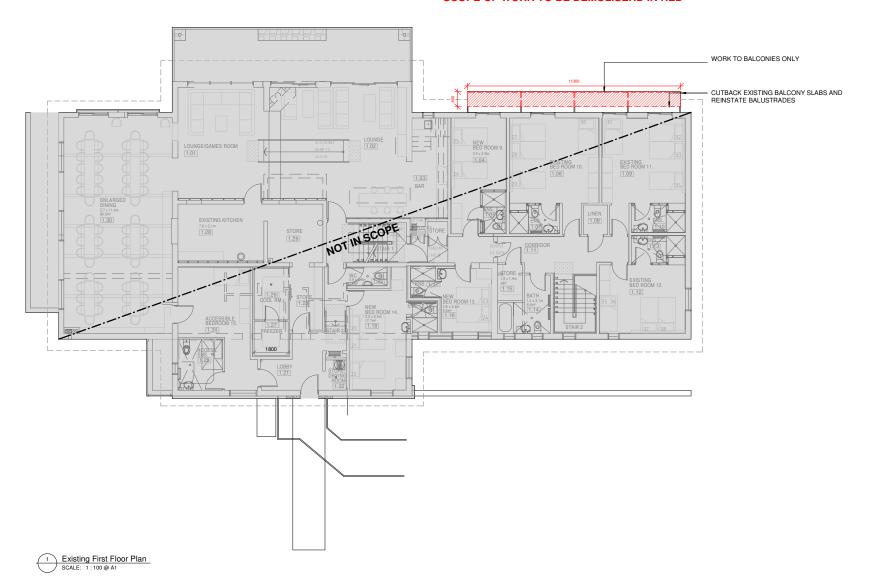

DEMOLITION NOTES

ALL DEMOLITION TO BE CARRIED OUT IN ACCORDANCE WITH THE REQUIREMENTS OF AS 2601 'THE DEMOLITION OF STRUCTURES'

ALL BUILDING MATERIALS ARISING FROM DEMOLITION TO BE DISPOSED OF IN AN APPROVED MANNER IN ACCORDANCE WITH COUNCIL, GUIDELINES AND ANY APPLICABLE REQUIREMENTS.

DURING DEMOLITION, STORMWATER & SANITARY DRAINAGE, WATER, ELECTRICITY & TELECOMMUNICATIONS ARE TO BE DISCONNECTED IN ACCORDANCE WITH RESPONSIBLE AUTHORITIES.

GENERAL CLEAN UP STANDARDS TO BE UNDERTAKEN - REMOVAL OF DUST, VEHICLES WHEELS

ALL EXCAVATION AND DEMOLITION TO BE CARRIED OUT DURING THE RESTRICTED TIMES DECIDED BY COUNCIL

EXISTING FINISHES ARE TO BE CAREFULLY PROTECTED FOR THE DURATION OF THE WORKS

DEMOLITION LEGEND

ZZ EXISTING ITEM TO BE DEMOLISHED.

PROPOSED ALTERATION

C 21.03.2024 DA B 15.03.2024 DA A 16.01.2024 DA



level 1 88 foveaux street surry hills nsw 2010 australia ph(02) 9212 6606 f(02) 9212 6670 w w w . b o k o r . c o m . a u


RIA AS/NZS ISO 9001 RIA AS/NZS ISO 45001 RIA AS/NZS ISO 14001

KOSCIUSKO ALPINE CLUB

KAC ALPENHOF LODGE PERISHER VALLEY

Existing First Floor Plan

SCOPE OF WORK TO BE DEMOLISEHD IN RED

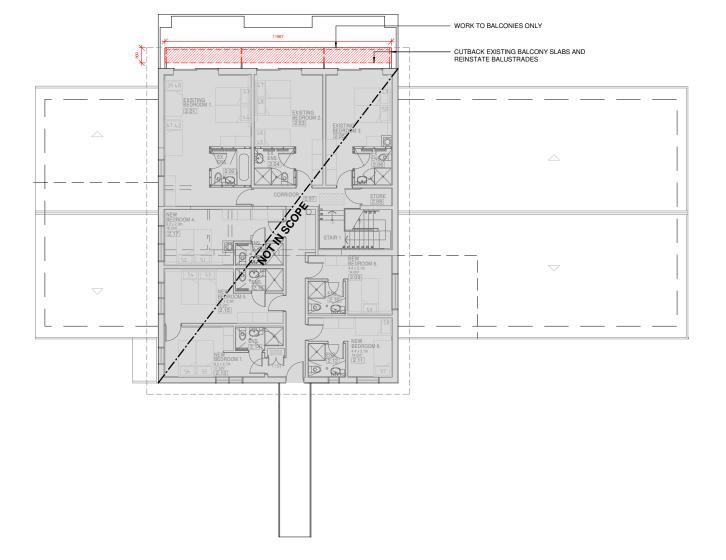

Existing Second Floor Plan SCALE: 1:100 @ A1

DEMOLITION NOTES

ALL DEMOLITION TO BE CARRIED OUT IN ACCORDANCE WITH THE REQUIREMENTS OF AS 2601 'THE DEMOLITION OF STRUCTURES'

ALL BUILDING MATERIALS ARISING FROM DEMOLITION TO BE DISPOSED OF IN AN APPROVED MANNER IN ACCORDANCE WITH COUNCIL, GUIDELINES AND ANY APPLICABLE REQUIREMENTS.

DURING DEMOLITION, STORMWATER & SANITARY DRAINAGE, WATER, ELECTRICITY & TELECOMMUNICATIONS ARE TO BE DISCONNECTED IN ACCORDANCE WITH RESPONSIBLE AUTHORITIES.

GENERAL CLEAN UP STANDARDS TO BE UNDERTAKEN - REMOVAL OF DUST, VEHICLES WHEELS

ALL EXCAVATION AND DEMOLITION TO BE CARRIED OUT DURING THE RESTRICTED TIMES DECIDED BY COUNCIL

EXISTING FINISHES ARE TO BE CAREFULLY PROTECTED FOR THE DURATION OF THE WORKS

DEMOLITION LEGEND

ZZ EXISTING ITEM TO BE DEMOLISHED.

PROPOSED ALTERATION

C 21.03.2024 DA B 15.03.2024 DA A 16.01.2024 DA

bok

architecture + interiors level 1 88 foveaux street surry hills nsw 2010 australia ph(02) 9212 6606 f(02) 9212 6670 w w w . b o k o r . c o m . a u


RIA AS/NZS ISO 9001 RIA AS/NZS ISO 45001 RIA AS/NZS ISO 14001

KOSCIUSKO ALPINE CLUB

KAC ALPENHOF LODGE PERISHER VALLEY

Existing Second Floor Plan

project no. 24087 A-102

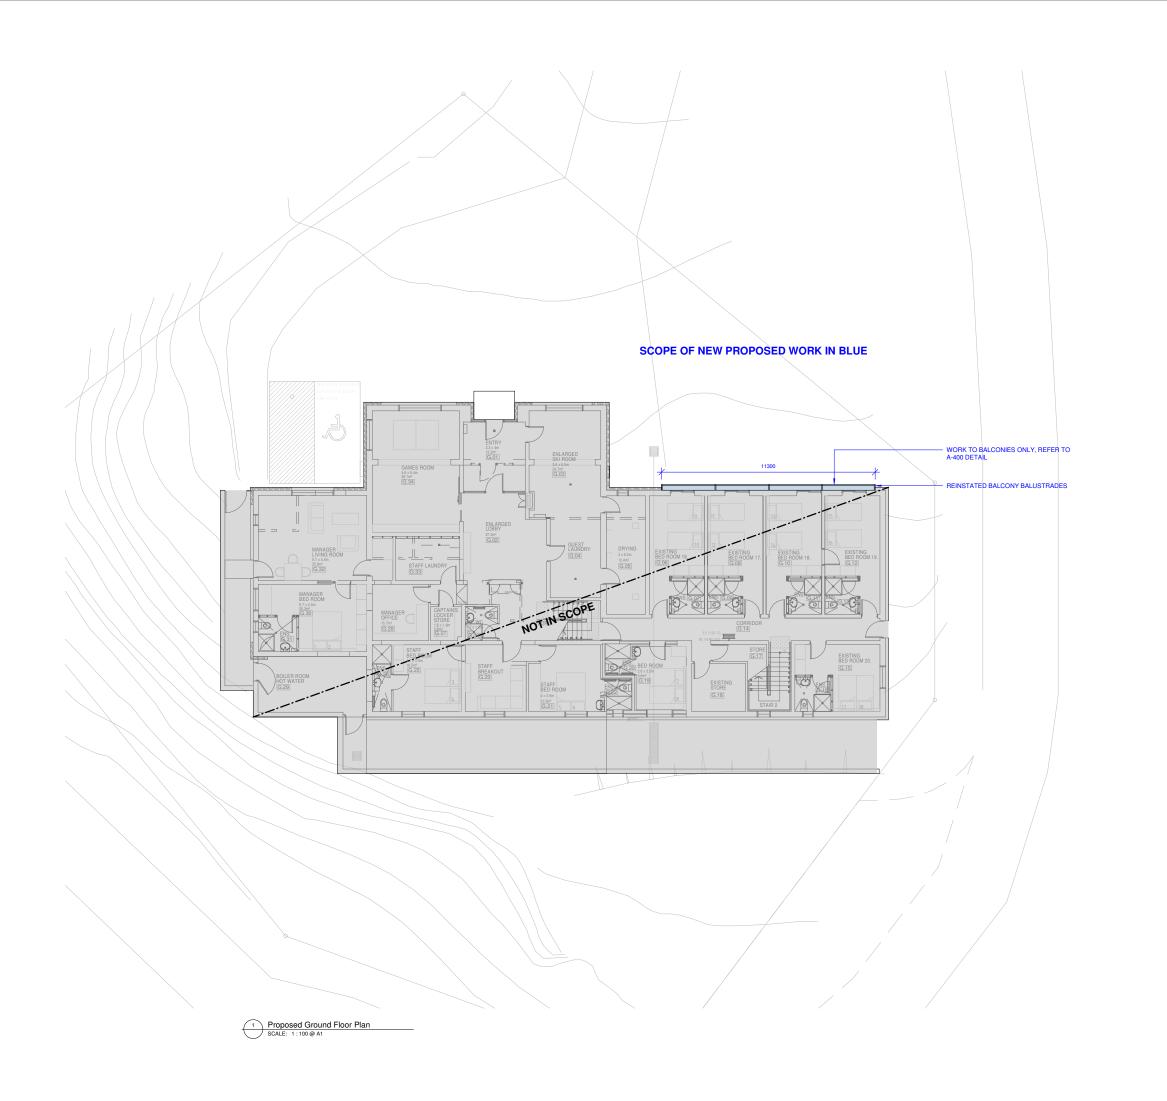



GENERAL NOTES

STRUCTURAL DESIGN TO COMPLY W/
AS1170.1,2,3 & 4
MATERIALS TO COMPLY WITH THE
FOLLOWING STANDARDS
CONCRETE
AS 3600
MASONRY
AS 3700
STEEL
AS 4100
GLAZING
AS 1288 &
METAL ROOF COVERING
AS 1288.6 AS 1288 & 2047 AS 1526.1

METAL HOOF COVERING AS 1526.1

ELECTRICAL METERS, DB, DUCTS, TELECOMS BOARDS, EQUIPMENT OR OTHER ELECTIRCAL MOTORS SERVING EQUIPMENT TO BCA CLAUSE E2.7

PORTABLE FIRE EXTINGUISHER TO BCA CLAUSE E16, AS 2444

STORMWATER DRAINAGE TO BCA CLAUSE F11, ASNEZ 3500.32

VENTILATION TO BCA CLAUSE F4.5, AS 1668.2, AS 3666

INTERNAL LININGS TO COMPLY WITH BCA CL. C1.10, Spec C1.10 & Spec C1.10

C1.10, Spec C1.10 & Spec C1.10a

SEPARATION OF ELECTRICAL EQUIPMENT TO BCA CI. C2.13 + Spec C1.1 + C3.4

BUILDING SEALING IS TO BE IN ACCORDANCE WITH BCA PART J3

THERMAL PERFORMANCE OF WALLS TO BE IN ACCORDANCE WITH BCA J1.5(b)

- THERMAL PERFORMANCE OF ROOFS TO BCA J1.3

- CHECK ALL LEVELS AND DIMENSIONS ON SITE

- CONTRACTOR TO CONFIRM POSITION OF ALL UNDERGROUND SERVICES PRIOR TO EXCAVATION

- USE FIGURED DIMENSIONS ONLY, DO NOT SCALE.

- ALLOW FOR ALL TELECOMMUNICATIONS AND ELECTRICAL LEAD-IN CABLING TO BE PLACED UNDERGROUND TO THE REQUIREMENTS OF THE RELEVANT AUTHORITIES.

DEMOLITION LEGEND

EXISTING ITEM TO BE DEMOLISHED. PROPOSED ALTERATION

C 21.03.2024 DA B 15.03.2024 DA A 16.01.2024 DA

bok

level 1 88 foveaux street surry hills nsw 2010 australia ph(02) 9212 6606 f(02) 9212 6670 w w w . b o k o r . c o m . a u

RI R AS/NZS ISO 9001 RI R AS/NZS ISO 45001 RI R AS/NZS ISO 14001


KOSCIUSKO ALPINE CLUB

KAC ALPENHOF LODGE PERISHER VALLEY

Proposed Ground Floor Plan

project no. 24087 A-110

SCOPE OF NEW PROPOSED WORK IN BLUE

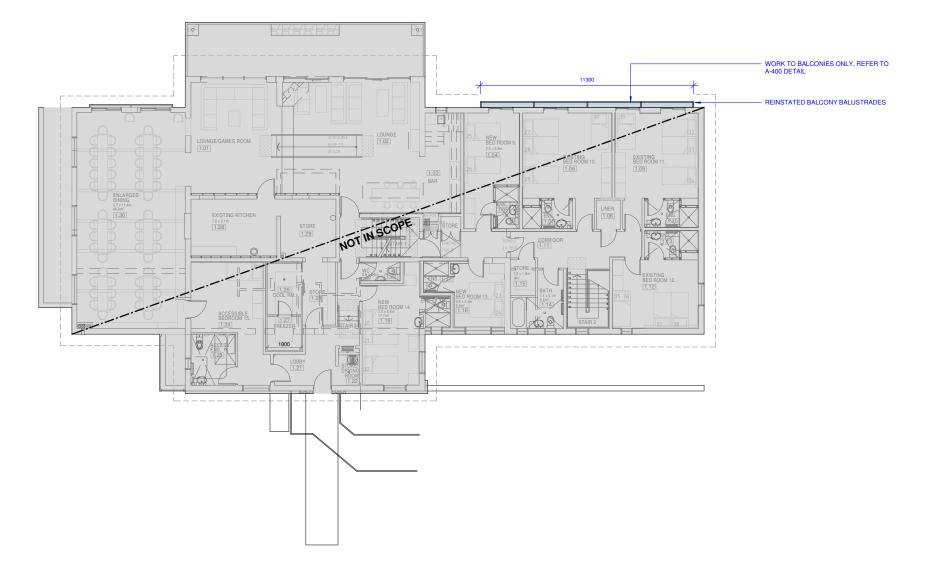

Proposed First Floor Plan
SCALE: 1:100 @ A1



GENERAL NOTES

STRUCTURAL DESIGN TO COMPLY W/
AS1170.1,2,3 & 4
MATERIALS TO COMPLY WITH THE
FOLLOWING STANDARDS
CONCRETE
AS 3600
MASONRY
AS 3700
STEEL
AS 4100 AS 1288 & 2047 AS 1526.1 GLAZING METAL ROOF COVERING

METAL HOOF COVERING AS 1526.1

ELECTRICAL METERS, DB, DUCTS, TELECOMS BOARDS, EQUIPMENT OR OTHER ELECTIRCAL MOTORS SERVING EQUIPMENT TO BCA CLAUSE D2.7

PORTABLE FIRE EXTINGUISHER TO BCA CLAUSE E16, AS 2444

STORMWATER DRAINAGE TO BCA CLAUSE F11, ASNEZ 3500.32

VENTILATION TO BCA CLAUSE F4.5, AS 1668.2, AS 3666

INTERNAL LININGS TO COMPLY WITH BCA CL. C1.10, Spec C1.108. Spec C1.109.

C1.10, Spec C1.10 & Spec C1.10a

SEPARATION OF ELECTRICAL EQUIPMENT TO BCA CI. C2.13 + Spec C1.1 + C3.4

BUILDING SEALING IS TO BE IN ACCORDANCE WITH BCA PARI J3

THERMAL PERFORMANCE OF WALLS TO BE IN ACCORDANCE WITH BCA J1.5(b)

- THERMAL PERFORMANCE OF ROOFS TO BCA J1.3

- CHECK ALL LEVELS AND DIMENSIONS ON SITE

- CONTRACTOR TO CONFIRM POSITION OF ALL UNDERGROUND SERVICES PRIOR TO EXCAVATION

- USE FIGURED DIMENSIONS ONLY, DO NOT SCALE.

- ALLOW FOR ALL TELECOMMUNICATIONS AND ELECTRICAL LEAD-IN CABLING TO BE PLACED UNDERGROUND TO THE REQUIREMENTS OF THE RELEVANT AUTHORITIES.

DEMOLITION LEGEND

EXISTING ITEM TO BE DEMOLISHED.

PROPOSED ALTERATION

| rev | date | issue | dra |
|-----|------------|-------|-----|
| Α | 16.01.2024 | DA | YA |
| В | 15.03.2024 | DA | YA |
| С | 21.03.2024 | DA | RV |



level 1 88 foveaux street surry hills nsw 2010 australia ph(02) 9212 6606 f(02) 9212 6670 w w w . b o k o r . c o m . a u

RIA AS/NZS ISO 9001 RIA AS/NZS ISO 45001 RIA AS/NZS ISO 14001


KOSCIUSKO ALPINE CLUB

KAC ALPENHOF LODGE PERISHER VALLEY

Proposed First Floor Plan

DA

SCOPE OF NEW PROPOSED WORK IN BLUE

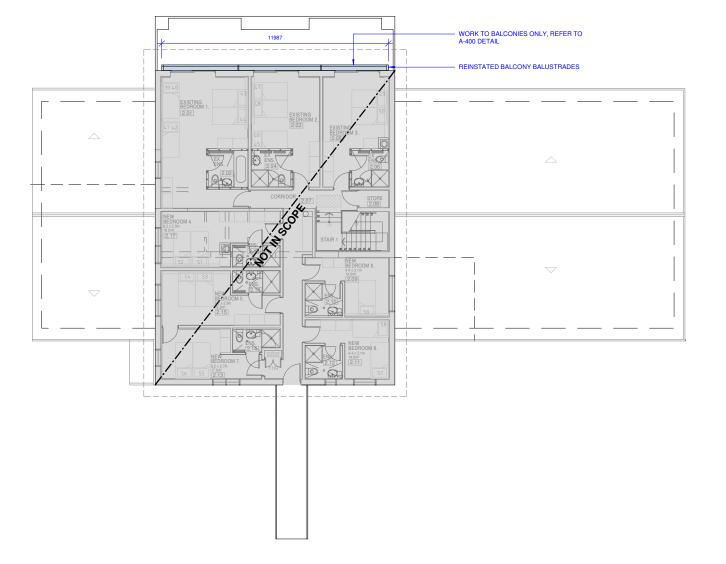





GENERAL NOTES

STRUCTURAL DESIGN TO COMPLY W/
AS1170.1,2,3 & 4
MATERIALS TO COMPLY WITH THE
FOLLOWING STANDARDS
CONCRETE
AS 3600
MASONRY
AS 3700
STEEL
AS 4100 GLAZING METAL ROOF COVERING AS 1288 & 2047 AS 1526.1

METAL HOOF COVEHING AS 1526.1

ELECTRICAL METERS, DB, DUCTS, TELECOMS BOARDS, EQUIPMENT OR OTHER ELECTIRCAL MOTORS SERVING EQUIPMENT TO BCA CLAUSE D2.7

PORTABLE FIRE EXTINGUISHER TO BCA CLAUSE E16, AS 2444

STORMWATER DRAINAGE TO BCA CLAUSE F11, ASNEZ 3500.32

VENTILATION TO BCA CLAUSE F4.5, AS 1668.2, AS 3666

INTERNAL LININGS TO COMPLY WITH BCA CL. C1.10, Spec C1.10 & Spec C1.10

C1.10, Spec C1.10 & Spec C1.10a

SEPARATION OF ELECTRICAL EQUIPMENT TO BCA CI. C2.13 + Spec C1.1 + C3.4

BUILDING SEALING IS TO BE IN ACCORDANCE WITH BCA PAIL J3

THERMAL PERFORMANCE OF WALLS TO BE IN ACCORDANCE WITH BCA J1.5(b)

- THERMAL PERFORMANCE OF ROOFS TO BCA J1.3

- CHECK ALL LEVELS AND DIMENSIONS ON SITE

- CONTRACTOR TO CONFIRM POSITION OF ALL UNDERGROUND SERVICES PRIOR TO EXCAVATION

- USE FIGURED DIMENSIONS ONLY, DO NOT SCALE.

- ALLOW FOR ALL TELECOMMUNICATIONS AND ELECTRICAL LEAD-IN CABLING TO BE PLACED UNDERGROUND TO THE REQUIREMENTS OF THE RELEVANT AUTHORITIES.

DEMOLITION LEGEND

EXISTING ITEM TO BE DEMOLISHED.

PROPOSED ALTERATION

C 21.03.2024 DA B 15.03.2024 DA A 16.01.2024 DA

bok architecture+interiors

level 1 88 foveaux street surry hills nsw 2010 australia ph(02) 9212 6606 f(02) 9212 6670 w w w . b o k o r . c o m . a u

RIA AS/NZS ISO 9001 RIA AS/NZS ISO 45001 RIA AS/NZS ISO 14001

KOSCIUSKO ALPINE CLUB

KAC ALPENHOF LODGE PERISHER VALLEY

Proposed Second Floor Plan

DA






EXISTING NORTH ELEVATION



EXISTING SOUTH ELEVATION

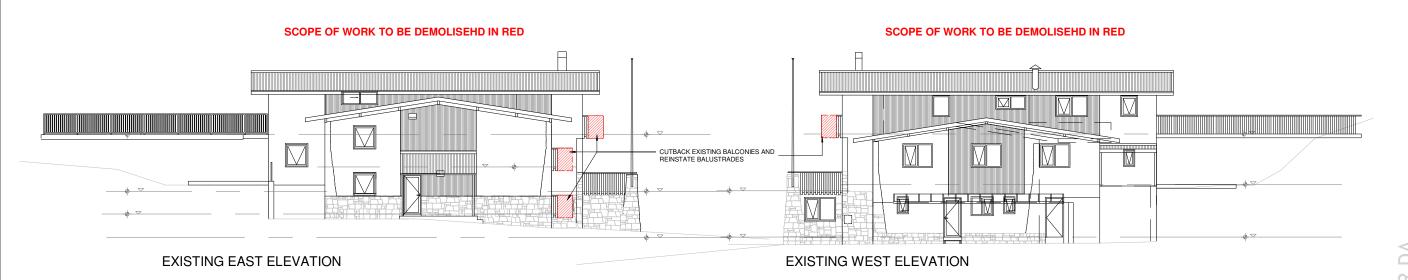

DEMOLITION NOTES

ALL DEMOLITION TO BE CARRIED OUT IN ACCORDANCE WITH THE REQUIREMENTS OF AS 2601 'THE DEMOLITION OF STRUCTURES'

ALL BUILDING MATERIALS ARISING FROM DEMOLITION TO BE DISPOSED OF IN AN APPROVED MANNER IN ACCORDANCE WITH COUNCIL GUIDELINES AND ANY APPLICABLE REQUIREMENTS.

DURING DEMOLITION, STORMWATER & SANITARY DRAINAGE, WATER, ELECTRICITY & TELECOMMUNICATIONS ARE TO BE DISCONNECTED IN ACCORDANCE WITH RESPONSIBLE AUTHORITIES.

GENERAL CLEAN UP STANDARDS TO BE UNDERTAKEN - REMOVAL OF DUST, VEHICLES WHEELS

ALL EXCAVATION AND DEMOLITION TO BE CARRIED OUT DURING THE RESTRICTED TIMES DECIDED BY COUNCIL

EXISTING FINISHES ARE TO BE CAREFULLY PROTECTED FOR THE DURATION OF THE WORKS

DEMOLITION LEGEND

EXISTING ITEM TO BE DEMOLISHED.

PROPOSED ALTERATION

C 21.03.2024 DA B 15.03.2024 DA A 16.01.2024 DA

level 1 88 foveaux street surry hills nsw 2010 australia ph(02) 9212 6606 f(02) 9212 6670 w w w . b o k o r . c o m . a u

RI R AS/NZS ISO 9001 RI R AS/NZS ISO 45001 RI R AS/NZS ISO 14001

KOSCIUSKO ALPINE CLUB

KAC ALPENHOF LODGE PERISHER VALLEY

Existing Elevations




PROPOSED NORTH ELEVATION



PROPOSED SOUTH ELEVATION

PROPOSED EAST ELEVATION

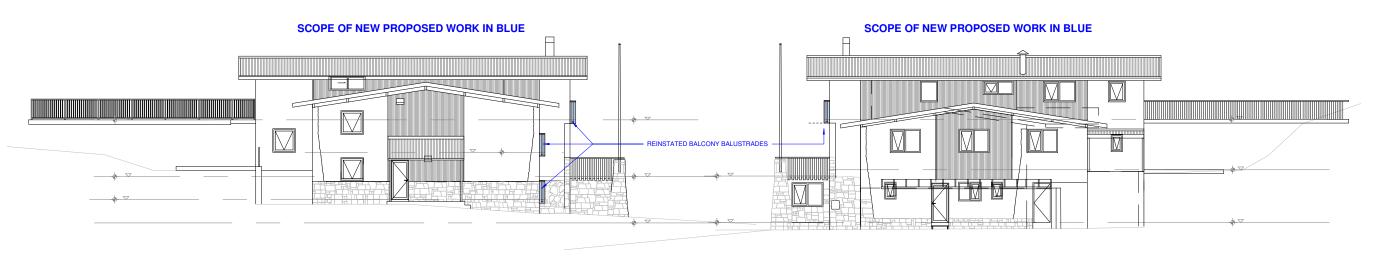

PROPOSED WEST ELEVATION



STRUCTURAL DESIGN TO COMPLY W/
AS1170.1,2,3 & 4
MATERIALS TO COMPLY WITH THE
FOLLOWING STANDARDS
CONCRETE
AS 3600
MASONRY
AS 3700
STEEL
AS 4100

GLAZING METAL ROOF COVERING AS 1288 & 2047 AS 1526.1

METAL ROOF COVERING AS 1526.1

ELECTRICAL METERS, DB, DUCTS, TELECOMS BOARDS, EQUIPMENT OR OTHER ELECTIRCAL MOTORS SERVING EQUIPMENT TO BCA CLAUSE 52.7

PORTABLE FIRE EXTINGUISHER TO BCA CLAUSE F1.6, AS 2444

STORMWATER DRAINAGE TO BCA CLAUSE F1.1, AS.NZS 3500.32

VENTILATION TO BCA CLAUSE F4.5, AS 1668.2, AS 3666

INTERNAL LININGS TO COMPLY WITH BCA CL. C1.10, Spec C1.10a

CSCARATION OF ELECTRICAL EQUIPMENT TO

C1.10, Spec C1.10 & Spec C1.10a

SEPARATION OF ELECTRICAL EQUIPMENT TO BCA CI. C2.13 + Spec C1.1 + C3.4

BUILDING SEALING IS TO BE IN ACCORDANCE WITH BCA Parl J3

THERMAL PERFORMANCE OF WALLS TO BE IN ACCORDANCE WITH BCA J1.5(b)

THERMAL PERFORMANCE OF ROOFS TO BCA J1.3

CHECK ALL LEVELS AND DIMENSIONS ON SITE

CONTRACTOR TO CONFIRM POSITION OF ALL UNDERGROUND SERVICES PRIOR TO EXCAVATION

USE FIGURED DIMENSIONS ONLY, DO NOT SCALE.

ALLOW FOR ALL TELECOMMUNICATIONS AND ELECTRICAL LEAD-IN CABLING TO BE PLACED UNDERGROUND TO THE REQUIREMENTS OF THE RELEVANT AUTHORITIES.

DEMOLITION LEGEND

EXISTING ITEM TO BE DEMOLISHED.

PROPOSED ALTERATION

WORK TO BALCONIES ONLY

| C | 21.03.2024 | DA | RW |
|-----|------------|-------|-------|
| B | 15.03.2024 | DA | YA |
| A | 16.01.2024 | DA | YA |
| rev | date | issue | drawn |




level 1 88 foveaux street surry hills nsw 2010 australia ph(02) 9212 6606 f(02) 9212 6670 w w w . b o k o r . c o m . a u

RI R AS/NZS ISO 9001 RI R AS/NZS ISO 45001 RI R AS/NZS ISO 14001

KOSCIUSKO ALPINE CLUB

PERISHER VALLEY

Proposed Elevations

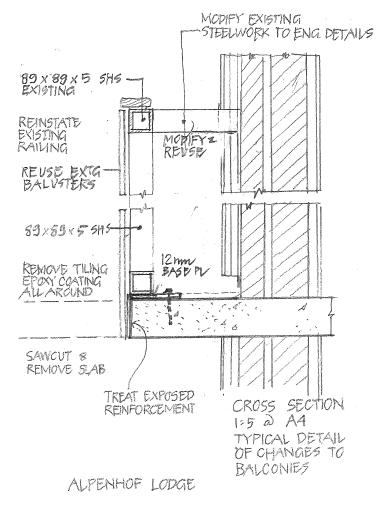

* REFER TO STRUCTURAL ENGINEER'S DETAILS

TYPICAL CROSS SECTION OF ALTERATIONS TO BALCONIES





level 1 88 foveaux street surry hills nsw 2010 australia ph(02) 9212 6606 f(02) 9212 6670 w w w . b o k o r . c o m . a u

RI R AS/NZS ISO 9001 RI R AS/NZS ISO 45001 RI R AS/NZS ISO 14001

KOSCIUSKO ALPINE CLUB

KAC ALPENHOF LODGE PERISHER VALLEY

Balcony Details

DA FOR

| project no. 24087 | | drawing no. | issue |
|----------------------|---------|-------------|--------------|
| YΑ | JB | 1:10 @ A1 | JAN 2024 |
| drawn | checked | scale | project date |





SITE ENVIRONMENTAL MANAGEMENT PLAN WORK SUMMARY

CONCRETE: REMEDIATION OF EXISTING CONCRETE DECKS AND REINSTATEMENT OF EXISTING RAILINGS.

EROSION AND SEDIMENT CONTROL: EROSION AND SEDIMENT CONTROL ARE NOT APPLICABLE AS THERE ARE NO EARTHWORKS OR DISTURBANCE OF SOIL.

NATIVE VEGETATION: MANAGEMENT OF NATIVE VEGETATION IS NOT APPLICABLE AS ALL WORKS ARE COMPLETED OVER EXISTING DRIVEWAYS.

WASTE MANAGEMENT PLAN, PLEASE SEE WMP PLAN.

NOISE AND VIBRATION POLLUTION: ALL CONCRETE SAWING WILL BE COMPLETED BETWEEN 9AM AND 5PM.

AIR POLLUTION: WET SAWS WILL BE UTILISED TO ELIMINATE DUST POLLUTION.

FUELS AND CHEMICALS: FUEL WILL BE STORED ON THE VEHICLES AND NOT STORED OVERNIGHT. ALL REFILING TO BE COMPLETED ON THE EXISTING HARDSTAND.

CONSTRUCTION WASTE MANAGEMENT NOTES

-BREAK UP ANY WASTE OR MISTAKES AND PUT IN CONCRETE BIN -RECYCLE CONCRETE:

FORMING BOARDS -REUSE AS MANY TIMES AS POSSIBLE AND THEN RECYCLE -STACK NEXT TO SUPPLY OF NEW FORM BOARDS FOR REUSE

CLEAN WOOD SCRAP -SCRAPS USED FOR FORMWORK ETC TO BE RECYCLED -STACK REUSABLE BITS NEXT TO WOOD SAW FOR REUSE -PLACE UNUSABLE SCRAPS IN WOOD RECYCLING BIN

-RECYCLE -PLACE IN METAL RECYCLING BIN SCRAP METAL

ALL OTHER WASTE -PLACE IN DUMPSTER -DISPOSE IN LANDFILL

COMMUNICATION PLAN

-WASTE PREVENTION AND RECYCLING ACTIVITIES WILL BE DISCUSSED AT THE BEGINNING OF EACH SAFETY MEETING

-AS EACH NEW SUBCONTRACTOR COMES ON SITE, THE RECYCLING CO-ORDINATOR WILL PRESENT HIM/HER WITH A COPY OF THE WASTE MANAGEMENT PLAN AND IDENTIFY RELEVANT AREAS

-THE SUBCONTRACTOR WILL BE EXPECTED TO MAKE SURE ALL THEIR CREWS COMPLY WITH THE WASTE MANAGEMENT PLAN

-ALL RECYCLING CONTAINERS WILL BE CLEARLY LABELLED

-LISTS OF ACCEPTABLE / UNACCEPTABLE MATERIALS WILL BE POSTED THROUGHOUT THE SITE



A 21.03.2024 DA

architecture+interiors

level 1 88 foveaux street surry hills nsw 2010 australia ph(02) 9212 6606 f(02) 9212 6670 w w w . b o k o r . c o m . a u

RI R AS/NZS ISO 9001 RI R AS/NZS ISO 45001 RI R AS/NZS ISO 14001

KOSCIUSKO ALPINE CLUB

KAC ALPENHOF LODGE PERISHER VALLEY

SITE ENVIRONMENTAL MANAGEMENT PLAN